

ADA RESTROOM INTERIOR ELEVATIONS FLOOR PLAN



ADA RESTROOM PLANS

A-2.3

herron-

ZONE CHANGE FOR DIANA MIN TU 40576 VIA HERRADURA, HMURRIETA, CA 92562

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ENLARGED PLAN NOTES & INTERIOR ELEVATION NOTES

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ROOF PLAN

REFERENCE ONLY



A-3.0

I. ROOFNIG MATERIAL SHALL BE NIN CLASS "N"
2. NO EAR'S CORNICE WIRTS.
3. PROTECTED DAYS—SANTHON RESISTANT OR NON COMBUSTBLE.
4. INSTRUCE MALL CONTRIVES NON-COMBUSTBLE.
5. INSTRUCE SALACHO-SHET EMBERS PARE OR 20 MIN RATED.
6. ENTERIOR SOCKES 20 MIN RATED.
6. ENTERIOR SOCKES 20 MIN RATED.

HIGH FIRE AREA CBC 2016 SECT 7A

OHAGIN FIRE AND EMBER RESISTANT I FIRE AND EMBER RESISTANT ROOF VENT LEGEND

OHAN I FIE AND DEEK RESSIAN I CC-856 4850-A. Y: TILE ROOF I
TIDS AS INCH DECH = 130 05 INCHES
TOTAL VENTLATION REMOVED FOR AREA 1" = 800 50 INCHES
TOTAL VENTLATION REMOVED FOR AREA 1" = 800 50 INCHES GN FIRE AND EMBER RESISTANT ICC-ESS 1650-A 'S' TILE ROOF TO SO INCHEMON 1100 SO INCHES

ATTIC VENTILATION AREA "2"

ATTIC AREA REDING VENTLATION = \$126 50 FT / 500 =

THO SOLN REGULATED BOTH SPIER AND LOWER ROOF AREA

ATTIC VENTILATION AREA "!"
ATTIC AREA REDING VENTLATION = 654 50 FT / 500 = 314 50.N.
TS 50.N. REQUIRED BOTH WITTER AND LOWER ROOF AREA 2) OHMAN FREI MO DEREN RESISTME 16-255-8450-M. S' TILE ROOT N TIDS 68 INCH DEM : "B 68 ROCES TOTAL VERTLATION PROVIDED FOR AREA T" : 94 50 ROCES TOTAL VERTLATION PROVIDED FOR AREA T" : 940 50 ROCES NITHE AND EMPER RESISTANT ICC-ESS 4650-A 15' TILE ROOM SO INCHEACH # 145 SO INCHES

INSTALL ESR 1650A O HAGINS FIRE AND EMBER RESISTANT ROOF VERTS MY 10° MIN 61. SCREENED VENTS (CONC. 9 SECONDARY VEN COVER (PROFILE) NOL. 8 50046-5 NET FREE AREA 8 4150 50 IN.

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FOLIAGO


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WIND DEPOSING "C CONSTITUTION REQUIREMENTS. ALL
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"ACCE."


ROOF PLAN NOTES


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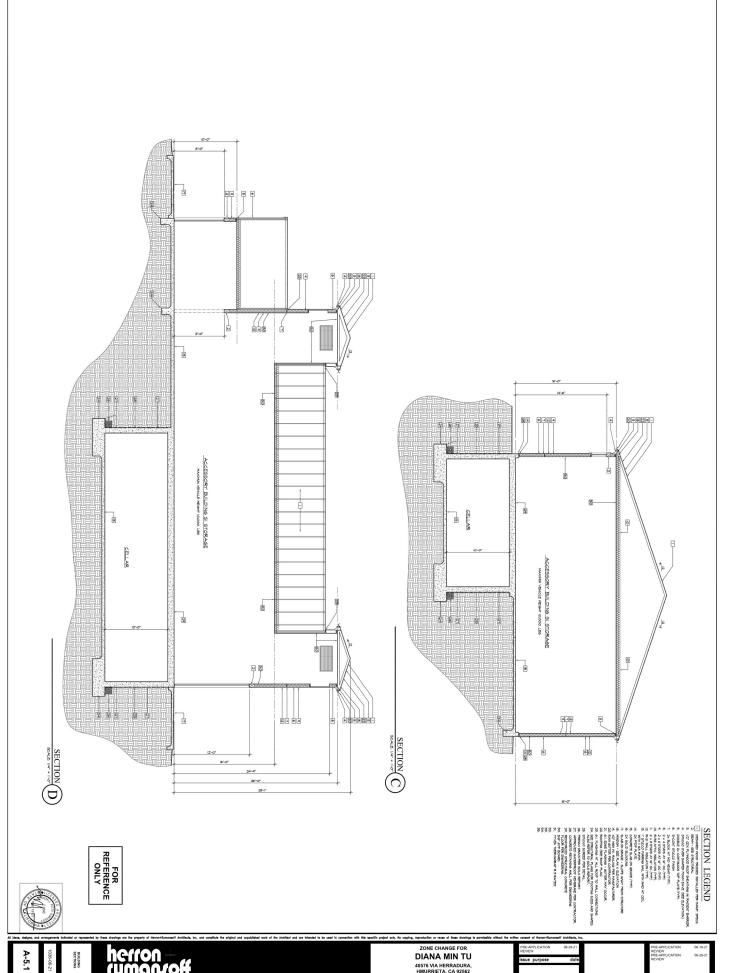
NEW EULD MOSS LOCATED IN HIGH FINE AREA SHALL COMPLY WITH RECOMPENDED OF CRC 2016, IEC NEXT EMPORED YOUR STRUCTURAL MEDIENS SHALL BE ANNAM NOWALL SIZE OF 4X YOR ADDITIONAL RECORDSHIPS FOR ROOTS AND DECKS, SEE CRC 2016, IEC NEXT.

ZONE CHANGE FOR DIANA MIN TU 40576 VIA HERRADURA, HMURRIETA, CA 92562



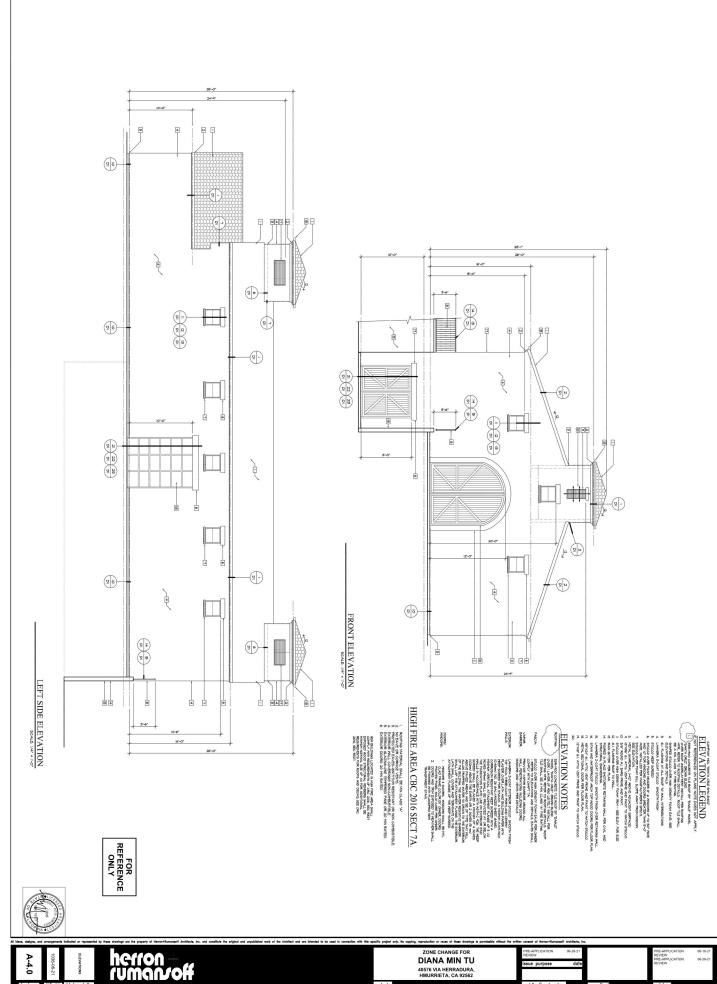

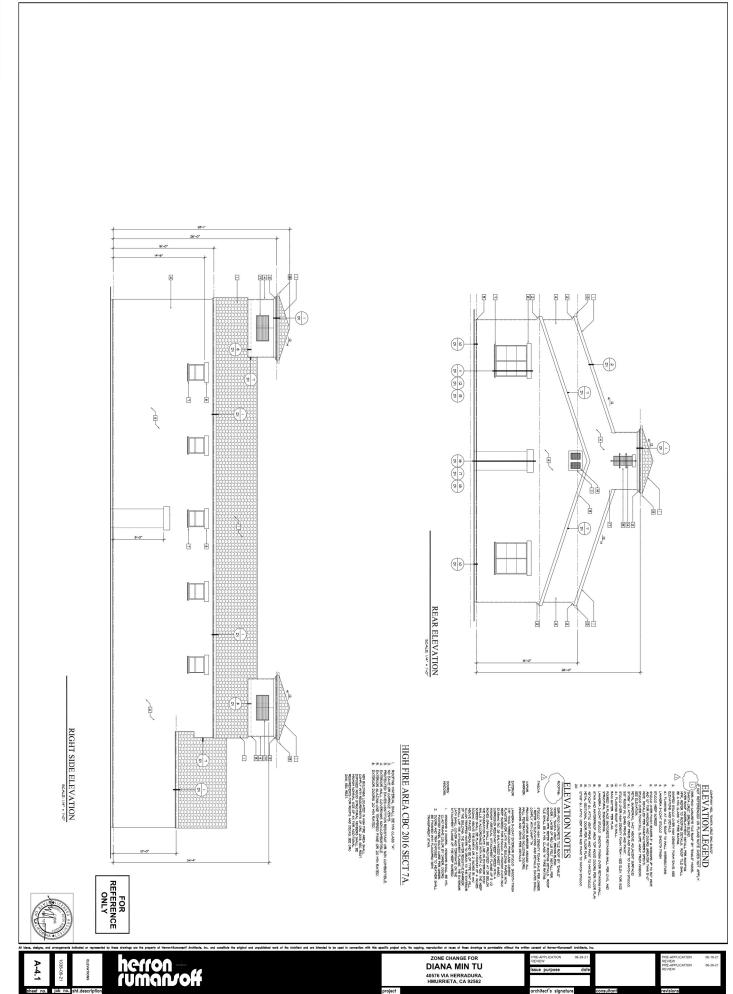

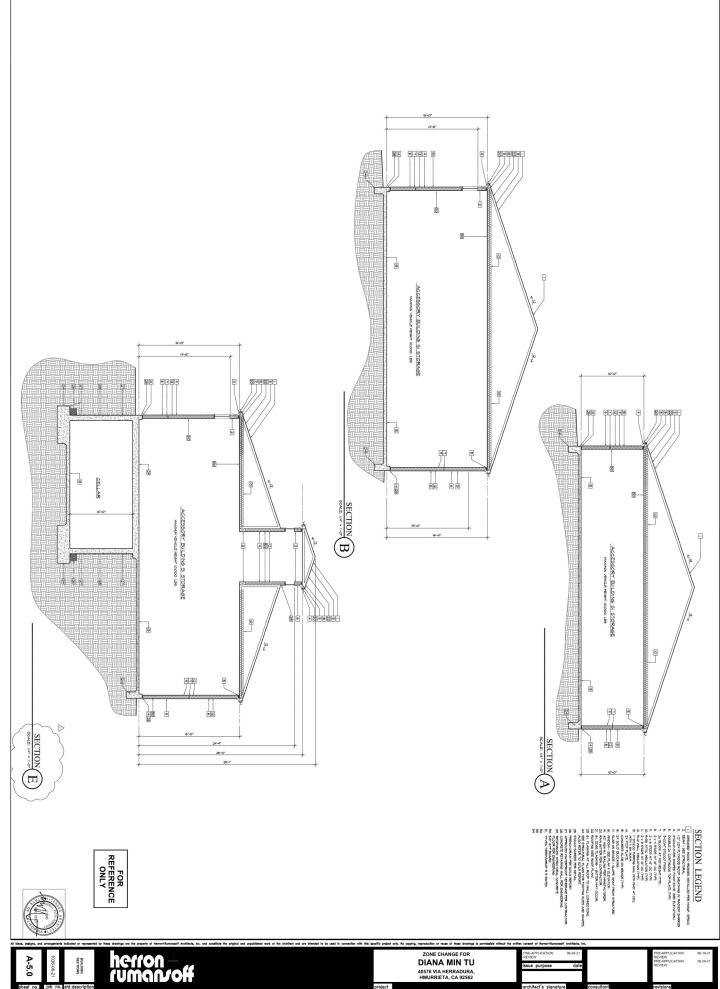

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DEPARTMENTORY

DAVID STRICK

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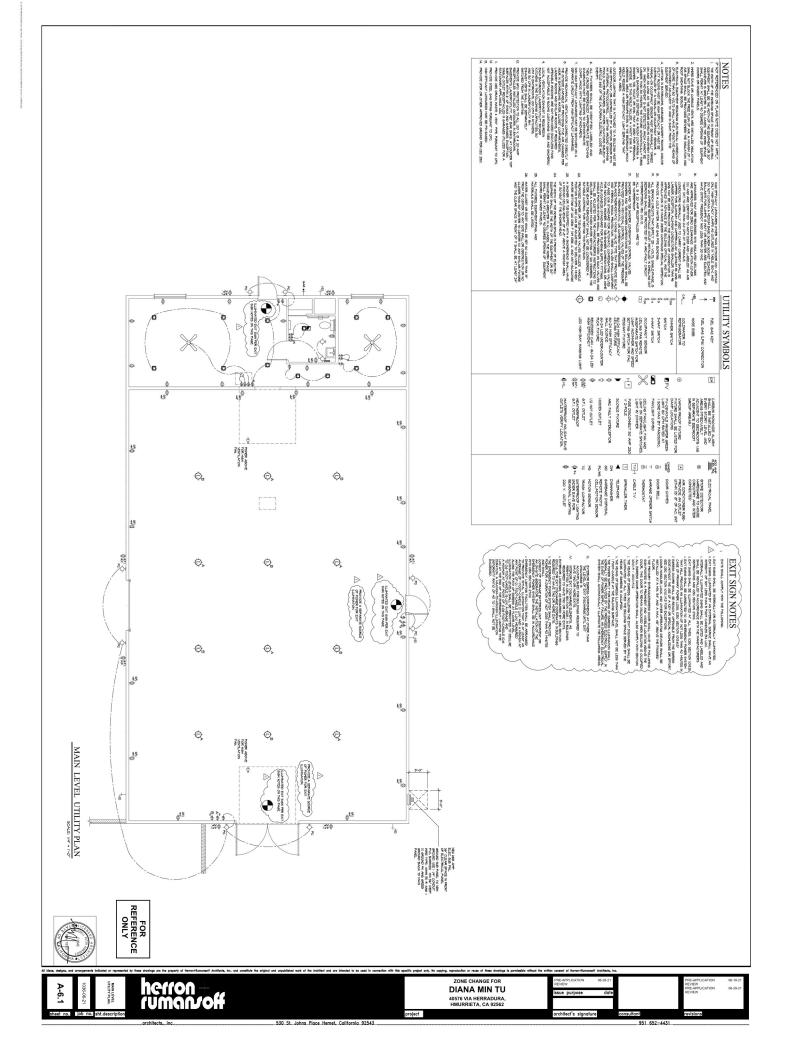
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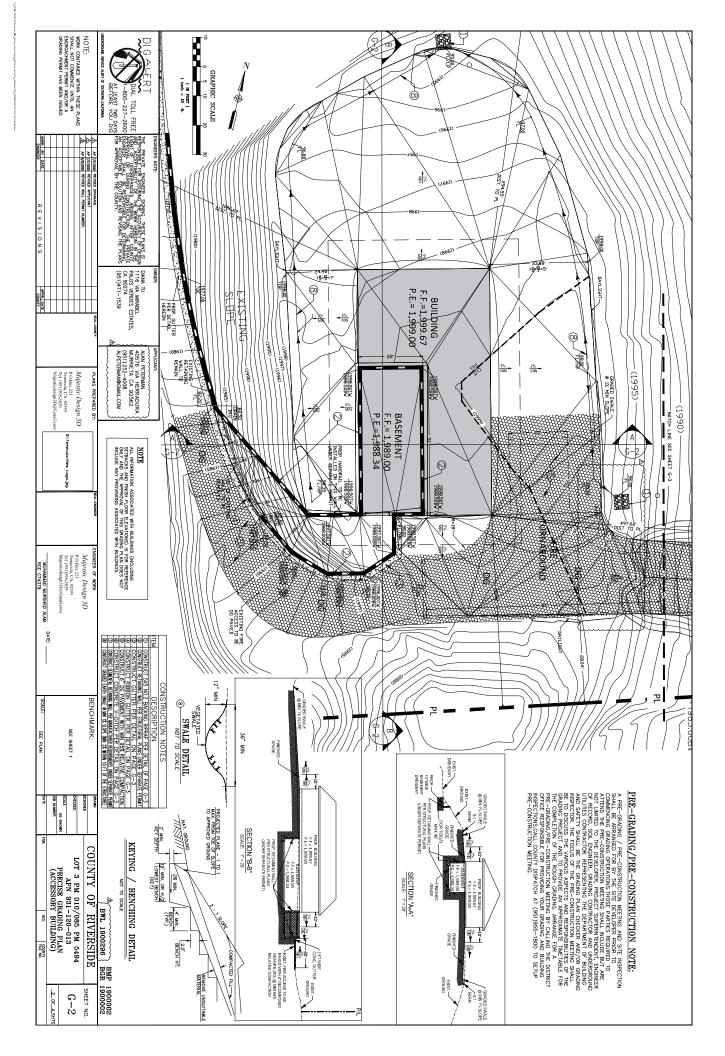





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WORK CONTAINED WITHIN THESE PLANS SHALL NOT COMMENCE UNTIL AN ENCROACHMENT PERMIT AND/OR A GRADING PERMIT HAS BEEN ISSUED. 'n 1. ALL GRADING SHALL CONFORM TO THE 2016 CALIFORNIA BUILDING ORDIC CHAPTERS T.7.1 8 AND APPENDIX-1 AS AMENDED BY ORDICANAGE 457. 2. ALL PROPERTY CORNERS, GRADING BOUNDARIES AND ALL CONSERVATION AREAS / LEAST SENSITIVE AREA (LSA) DETERMINED BY THE ENVIRONMENT LA PROCRAMS DEPARTAINT (EPS) SHALL BE CLEARLY DELINEATED AND STAKED IN THE FILLD PRIOR TO WORK WITH WORK UNDER THIS GRADING PERMIT SHALL BE LIMITED TO WORK WITH WORK UNDER THIS GRADING PERMIT SHALL BE LIMITED TO WORK WITH WORK UNDER THIS GRADING PERMIT SHALL BE LIMITED TO WORK WITH WORK OF A STAKED AND A SEPARATE REVEW APPROVAL (FEMILIES ALL WORK WITH WITH PROPERTY LIMITED THOM THE THANSPORTATION OF A SOLIS FREUNKLARY SOLIS INVESTIGATION BY EARTH STRATA GEOTECHNICAL SERVICES, IN CANTED WAY STRUCTURES SHALL COMPLY WORK AND STAKED THE SOLIS SERVICES. IN CONTROL WAS AND TRAIL WITH A SOLIS SERVICES OF THE SECONDS SERVICES OF THE ENGINEER OF RECORDS. 9. MANIMUM CUT AND FILL SLOPE = 2:1 (HORIZONIA. TO VERTICAL) 10. NO FILL SHALE BE PLACED OF KEEDS, TOPSOIL AND OTHER DELETEROUS MATERIAL FILLS SHOULD BE PLACED IN THIS HETS (B-HOST HAX OR AS RECOMMENDED IN SOULS REPORT), COMPACTED AND TESTED AS GRAUNG PROCESS UNTIL FILL GRADES ARE ATTAINED, ALL FILLS ON SLOPES STEEPER THAN 5 TO 1 (H/V/) AND A HEIGHT GREATER HAM 5 FEET SHALL BE KEYD AND BENCHED INTO FIRM NAIPMA SOUL FOR FULL SUPPORT, THE BENCH UNDER THE TOE MUST BE 10 FEET WIDE MIN. THE SLOPE STABILLYF FOR CUT AND FILL SLOPES ONER 30 IN VERRICD HIGHT, OR CUT SLOPES STEEPER THAN 2: HAVE BEEN VERRICD HIGHT, OR CUT SLOPES STEEPER THAN 2: THAN SHALE NO ROCK OR SHALE HAW 10; THOSES STEEPER HAW 2: HAWAMIM DIMENSON GREATER THAN 12; NOTES SHALL BE BURED OR PLACED IN FILLS CLOSES THAN 10 FEET TO THE RINASHD GRADE. ≓ 20. i 7. i 5. 13. RECORD THE CONTRACTOR SHALL NOTIFY THE BUILDING AND SAFETY DEFARMANY AT LEAST 24 HOURS, IN DOWNOUS TO ROULEST FRUSH LOT GRADE AND DRAINAGE INSECTION. THIS INSECTION MUST BE APPROVED PRIOR TO BUILDING PERMIT FINAL INSPECTION OF EACH LOT, CONTRACTOR SHALL NOTIFY UNDERGROUND SERVICE ALERT TWO DAYS BEFORE DIGGING AT 1-880-422-4133. BIVERSIDE COUNTY ENVIRONMENTAL COMPLIANCE INSPECTOR PRIOR TO COMMENCEMENT OF GRADING OPERATIONS. GENERAL NOTES DRAINAGE and EROSION/DUST CONTROL PROVIDE 5" WILE BY I HIGH BERN ALONG THE TOP OF ALL FILL SLOPES STEEPER HAM 3.1 (HORGOVIA, HO NETICAL), HE GROUND SHEALE BE SLOPED MAY FROM THE BUILDING FOUNDATION SHALL BE SLOPED MAY FROM THE BUILDING AT A SLOPE OF NOT LESS "HAM ONE UNIT SETTICAL IN 20 UNITS HORGOVIAL JESS SLODE) FOR A MIN, DAS MACE OF 10 FEET MOREOGRAPH AND THE STANDARD THE TOUNDATION, OR STANDARD OF MATTER COURSES SHALL BE FEMILIFED. DRAINAGE ACROSS THE PROPERTY LINE SHALL NOT EXCEED THAT WHICH EXISTED PROPERTY LINE SHALL NOT EXCESS OWNEWHATED PRAINAGE SHALL BE CONTINUED ON SITE OR DIRECTED TO AN APPROVED DRAINAGE FAULTY. PRESCON OF THE GROUND IN THE AREA OF DISCHARGE SHALL BE PROPERTED BY INSTALLATION OF NOWLEDGE A PARED SHALD BRAINS OR OTHER DEVICES. A PARED SLOPE INTERCEPTOR DRAIN ALONG THE TOP OF CUT SLOPES, WHERE THE DRAINAGE FAITH IS GREATER THAN 40 FERT OWNERS THE CUT SLOPE. DUST SHALL BE CONTROLLED BY WATERING OR OTHER APPROVED METHODS. FUGITIVE DUST CONTROL: CONSTRUCTION SITES SUBJECT TO PAND FUGITIVE DUST MITIGATION SHALL COMPLY WITH AGMD RULE 403.1. RING ROUGH GRADING OPERATIONS AND PRIOR TO CONSTRUCTION PRIMARENT DRAINAGE STRUCTURES, TEMPORARY DRAINAGE WITHOUT (BEST MANAGEMENT PRACTICES, BMPS) SHALL BE OVICED TO PREVENT PONDING WATER AND DAMAGE TO ADJACENT DREPIES SHALL BE CONTROLLED BY WATERING OR OTHER APPROVED DIAL TOLL FREE 1-800-227-2600 AT LEAST TWO DAYS THE PROMET PASSED SAME THE PASSES DIMAN LITTLE PROMET PASSES TO THE PASSES DIMAN LITTLE PASSES DIMAN LITTLE PASSES DIMAN LITTLE PASSES PASSES DIMAN LITTLE PASSES PASSES DIMAN LITTLE PASSES PASSES DIMAN LITTLE PASSES DIMAN LITT A-P (NATIONAL REVISED WALL PERMIT NUMBER, SOURCE OF MIFORT ASSED. A-P (NATIONAL REVISED WALL PERMIT NUMBER, SOURCE OF MIFORT ASSED.) DECIDENCE DOUL ENGNEER SHALL PREPARE FINAL COMPACTION 23. A RECISTERED OVIL ENGNEER SHALL PREPARE FINAL COMPACTION 24. A RECISTERED SHALL PREPARE FINAL DEPOISE WEEN AND SPACEMENT FOR RECISTER SHALL PRESUME END ON THE RECISTER SHALL PRESUME ENGNE FOR AND FINAL PRESUME ENGNE FOR HOLD FOR THE FORM MATER SOLUBLE SULFAIT CONTROL RESUMEDIAL LEGISLES IF ED 20, WATER SOLUBLE SULFAIT CONTROL RESUMENTAL LOT GRADING, THE EXCEPT FOR MON-FRACT SHALL RECISTE THE STATE ASSECTION ALLESANCE IF RECESSIONAL LOT GRADING, THE EXCEPT FOR MON-FRACT SHALL RECISTER A LICENSED PROFESSIONAL FOR AND SHALL PROPER FOR SHALL PRESUME SALL PROPERSONAL FOR SHALL PROPERSONAL CONTROL OF THE BUILDING FRAMIL CONTROL OF THE GUILDING FRAMIL CONTROL SHALL RECORD THE SHALL PROPERSON FOR THE SHALL PROPERSON FOR SHA PRECISE CRADE 7. A REGISTEED CIVIL ENGINEER SHALL SUBMIT TO THE BUILDING AND 7. AFTEN DEPARTMENT WHITEN FINAL CERTIFICATION OF COMPLETION 7. GRADING IN ACCORDANCE WITH THE APPROVED GRADDING PLAN PRIOR 7. O REQUEST OF PRECISE GRADING INSPECTION. 2. ALL EXISTING DRAMMOR COURSES, AND STORM DRAWN FACULITIES SHALL AND CONTINUE TO PLINCTION, PROJECTS AND STORM DRAWN FACULITIES SHALL AND CONTINUE TO PLINCTION, PROJECTS AND STORM DRAWNAGE PROVISIONS WIGST BE USED TO PROTECT ADJOINING PROPERTIES DURING GRAMING OFERATIONS. PROPERTIES DURING GRAMING OFERATIONS PROPERTIES DURING GRAMING OFERATIONS PROPERTIES DURING GRAMING OFERATIONS PROPERTIES DURING GRAMING OFERATIONS PROJECTS OF THAM 4 TO 1 (1/1/1): FOR ALL SLOPES EDURING PROPERTIES DURING GRAMING ASSOCIATION OF BE REASTERD UNITED TO BE PLANTING A PROPERTIES OF 20 OF CENTER OF BE REASTERD UNITED TO BE PLANTING SHALL BE PROVIDED WITH AN IN-ROUNDED WITH AN IN-ROUNDED WITH AN IN-ROUNDED GRAMING AND INFORMATION OF SHALLS AND TREES HAT TO EXCEED 10' OR A COMPINATION OF SHALLS AND TREES HAT TO EXCEED WITH A PROPORT SHALL BE PROVIDED WITH AN IN-ROUNDED WITH AN IN-ROUNDED WITH AND THE OFFICE AND AND A PROSERE UPPORT COMPACTION OF THE OFFICE AND AND A PROSERE UPPORT COMPACTION OF THE OFFICE AND AND A PROVIDED WITH AN IN-ROUNDED WITH AND THE OFFICE AND AND A PROVIDED WITH AN IN-ROUNDED WITH AND THE OFFICE AND A PROVIDED WITH AN IN-ROUNDED WITH AND ADDRESS HAT SHALL BE STANDARD AND A PROVIDED WITH AN IN-ROUNDED WITH AND A COUNTY OF THE OFFICE AND A PROVIDED WITH AN IN-ROUNDED WITH AND A PROVIDED WITH A PROVIDED WITH AND A P 22. 21. NPDES: WHE DISTURBED: ALL INFORMATION ASSOCIATED WITH BUILDINGS (INCLUDING SETBACKS AND FF LEVATIONS) IS FOR REFERENCE ONLY AND THE APPROVAL OF THIS GRADING PLANS DO NOT INCLUDE ANY PROVISIONS ASSOCIATED WITH BUILDINGS. CONSTRUCTION SITE BEST MANAGEMENT PRACTICES (BMPS) FOR THE MANAGEMENT OF STORM WHITER MON NON-STOWN WHITER MOSTAGES SHALL BE DOCUMENTED ON THE GRADING PLAM, ARRANGEMENTS SHALL BE MADE BY THE DEVELOPER TO RETAIN THE SMPP ON THE DESIGN THROUGHOUT THE TIME OF CONSTRUCTION, THE MAPEMENTATION ARRANGEMENTS SHALL BE MADE BY THE DEVELOPER TO MANUZE WHITE TOWN AND SEMMENTATION ARRANGEMENTS SHALL BE MADE BY THE DEVELOPER TO MANY AND THE DEVELOPER T ENGINEERS NOTES: COMPLETION OF WORK WHEN ONE ACRE OR MORE IS BEING ALAN PETERMAN 40576 VIA HERRADURA MURRIETA CA 92562 (951) 252-4008 ALPETERMAN®GNAIL.COM Majestic Design 3D c 223 Ia, CA. 92593 1)595-3839 :design3D@Gn PRECISE SITE ADDRESS 40576 VIA HERRADURA MURRIETA CA 92562 RIVERSIDE, CALIFORNIA ALL 2. ESCOSIO CONTROL DAN'S SUML RE IMPOLIDATION AND AMENIARY TO PRECENT 4. AND CONTROLLED SUM AND ASSESSMENT OF SUM IN RANGET FROM DESTINENCE TO PRECENT 15. SEDMENT CONTROLLED SUM AND ASSESSMENT OF SUM ASSESS DO CONSTRUCTION SITES SHALL BE MANATANED IN SUCH A CONDITION THAT A STORM STORMWITE (ONE-STORMWITE DOCUMENT) STORMWITE (ONE-STORMWITE DOCUMENT) STORMWITE (ONE-STORMWITE DOCUMENT) MAINT TO CONSTRUCTION ACTION FOR THAT IN SALES BY STATEMED CREEKE ACTION MAINT TO CONSTRUCTION ACTION FOR THAT IN SALES BY STATEMED CREEKE ACTION MAINT TO CONSTRUCTION ACTION FOR THAT IN SALES BY STATEMED CREEKE ACTION MAINT TO CONSTRUCTION ACTION FOR THAT IN SALES BY STATEMED CREEKE ACTION MAINT TO CONSTRUCTION ACTION FOR THAT IN SALES BY STATEMED CREEKE ACTION MAINT FOR DOCUMENT STEAM CLARING OF CREEKE ACTION MAINT FOR ACTION FOR THAT IN SALES BY STATEMED CREEKE ACTION MAINT FOR ACTION FOR THAT IN SALES BY STATEMED CREEKE ACTION MAINT FOR ACTION FOR THAT IN SALES BY ACTION FOR THAT IN SALES BY ACTION MAINT FOR ACTION FOR THAT IN SALES BY ACTION FOR THAT IN SALES BY ACTION FOR THAT IN SALES BY ជ APN 931-120-013 CSTREEN IN POOL OF LEWIS TRAIN GROTELANDLE, SERVICES, NO. A RESTREEN ON DIMENSION PROPERTY PROPERTY AND BROWNESS OF CONTROL OF THE WAS SERVICED. WHITH HE STE WAS SERVICED FOR THE WAS SERVICED. THE WAS SERVICED FOR THE WAS SERVICED FOR THE WAS SERVICED FOR THE WAS SERVICED. THE SERVICED FOR THE SERVICED FOR THE WAS SERVICED FOR THE WAS SERVICED FOR THE WAS SERVICED. THE SERVICED FOR THE WAS SERVICED. THE WAS SERVICED FOR THE W **GRADING PLAN** NOTE: ENGINEER OF RECORD IS NOT RESPONSIBLE FOR ANY CHANGES. THAT IS NOT IN COMPLIANCE WITH THE COUNTY APPROVED GRADING PLANS MADE DURING GRADING OPERATION. SOILS ENGINEER CERTIFICATE STATEMENT: NAME & SIGNATURE OF THE SOILS ENGINEER Temecula, CA. 92593 Tel. (951)595-3839 Majesticdesign3D@Gn Majestic Design 3D MUHAMMAD MURSHED ALAM RCE C74379 STAMP DATE E AARTHWORK QUANTITIES RAW 017- 900 C.Y. RAW 107- 100 C.Y. RAW 107-SOURCE OF IMPORT: EARTH STRATA GEOTECHNICAL SERVICES, INC 42184 FEMBOTON AVENUE, 42184 FEMBOLLA, CA 92590 STELL (951)461-4028 EMAIL: GADALLAGEARTH-STRATA.COM DESCRIPTION OCCUSION ESTABLE DE DECIME REPREPERTAL OF PAGE G-3 (**OCCUSION ESTABLE BULL ESTABLE PER DETAL OF PAGE G-3 OCCUSION ESTABLE BULL ESTABLE DETALL ON PAGE G-3 (**OCCUSION ESTABLE BULL ESTABLE DETALL ON PAGE G-3 OCCUSION ESTABLE BULL ESTABLE BULL ESTABLE DETALL ON PAGE G-3 (**OCCUSION ESTABLE BULL ESTABLE BULL ESTABLE BULL ON PAGE G-3 OCCUSION ESTABLE BULL ESTABLE BULL ESTABLE BULL ON PAGE G-3 OCCUSION ESTABLE BULL ESTABLE BULL ESTABLE BULL ON PAGE G-3 OCCUSION ESTABLE BULL ESTABLE BULL ESTABLE BULL ON PAGE G-3 OCCUSION ESTABLE BULL BULL ESTABLE BULL ESTABLE BULL EST THE FOUND MONUMENT AT THE INTERSECTION OF VIA HERRADURA AND LA CRESTA AVE. BENCHMARK: ASSUMED ELEVATION: 1970.53 LEGAL DESCRIPTION 21.11 ACRES M/L IN PAR 3 PM 010/085 PM 5494 APN 931-120-013 SOILS ENGINEERS TOPOGRAPHIC SOURCE CUT AREA UNDER BUILDING SHOULD BE OVER EXCAVATED PER SOILS ENGINEER'S RECOMMENDATIONS. LOCATION OF LEACH LINES AND SEPTIC TANK TO BE VERIFIED AND APPROVED BY THE SOILS ENGINEER. NOTE FLOW LINE HIGH PRINT FINISH GRADE FINISH SUPFACE FINISH FLORE THE SLOPE THE SLOPE DECOMPOSED GRANITE PAVEMENT (DG) AS SHOWN CALLE BANDIDO SHEET INDEX SHEET 6-1 THE SHEET SHEET 6-2 PRODUCE GRADING PLAN (ACCESSORY BUILDING) SHEET 6-2 PRODUCE GRADING PLAN (EWE FIRE, ACCESS ROAD SHEET 6-4 PRODUCE GRADING PLAN (TENMS COURT) NO WORK SHALL COMMENCE WITHIN THE ROAD RIGHT OF WAY WITHOUT ISSUANCE OF ENCROACHMENT PERMIT BY TRANSPORTATION DEPARTMENT. NOTE NOTE: COUNTY OF RIVERSIDE LOT 3 PM 010/085 PM 5494 APN 931-120-013 TITLE SHEET THE ENGINEER PREPARED THE GRADING PLAN HAS VEHIELD THE CONSISTENCY BETWEEN ON-SITE GRADING INFORMATION AND THE WORK WITHIN THE R/W APPROVED BY THE TRANSPORTATION EPARTMENT. THE ENGINEER WHO PREPARED AND SIGNED THESE PLANS HAS EPIED THAT INCOMMATION SHOWN ON THESE PLANS IS CONSISTENT WITH THE ROAD PLAN APPROVED BY THE TRANSPORTATION DEPARTMENT. THE ENGINEER OF RECORD WHO PREPARED AND SIGNED THE GRADING PLANS HAS VERRIED THAT THE PROPOSED BORAINAGE SYSTEM IS CONSITENT WITH THE THE NATURAL DRAINAGE PATTERN OF THE SITE AND WILL NOT ADVERSELY AFFECT ADJUGGENT PROPERTIES. 100 FEET AROUND ALL STRUCTURES: VEGETATION SHALL BE MANINERED FER RC. 0800, 787.7 DRIVEWAY SURFACES AREA AS NOTED ARE DESIGNED TO SUSTAIN THE 40,000 LBS DRIVEWAY SURFACE NOT TO EXCELS 15% GAME DRIVEWAY SURFACE ROAD DRIVEMAYS MUST BE ALL MEATHER SURFACE ROAD BWT 19000002 BWT 19000002 FIRE DEPT. NOTES VICINITY MAP NO. SCALE SHEET NO. G-1





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WORK CONTAINED WITHIN THESE PLANS
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40576 VIA HERRADURA
MURRIETA CA 92562
(951) 252-4008
ALPETERMAN@GMAIL.COM Majestic Design 3D P.O.Box 223 Pemecula, CA. 92593 Tel. (951)595-3839 Majesticdesign3D@Gmail.com 1+00.00 PER BUILDING STRUCTURAL PLANS W/A W/A RETAINING WALL PROFILE VIA HERRADURA Station 10 Majestic Design 3D
P.O.Box 223
Temecula, CA. 92593
Tel. (951)595-3839
Majesticdesign5D@Gmail.com MUHAMMAD MURSHED ALAM RCE C74379 SCALE: 1" = 10' APN# 931-120-019, APN# 931-120-030 Δ=90°00'0 R=300' L=471.24' APN# 931-120-010 +00.00 BENCHMARK: 2=86°48'35" R=300' L=454.54' SEE SHEET APN# 931-120-037 GRADING FOR MAIN HOUSE PER BGR 1800331 INDEX MAP SCALE 1"=150' COUNTY OF RIVERSIDE SHEET NO. Ü, HOUSE LOT 3 PM 010/085 PM 5494 APN 931-120-013 PRECISE GRADING PLAN (TENNIS COURT) APN# 931-130-007 NATURAL WATER COURSE APN# 931-120-036 1960.00 5+00.00 FILE NO. G-4 SHEET NO. VAENIDY IV CHERLY N06°06'16"W
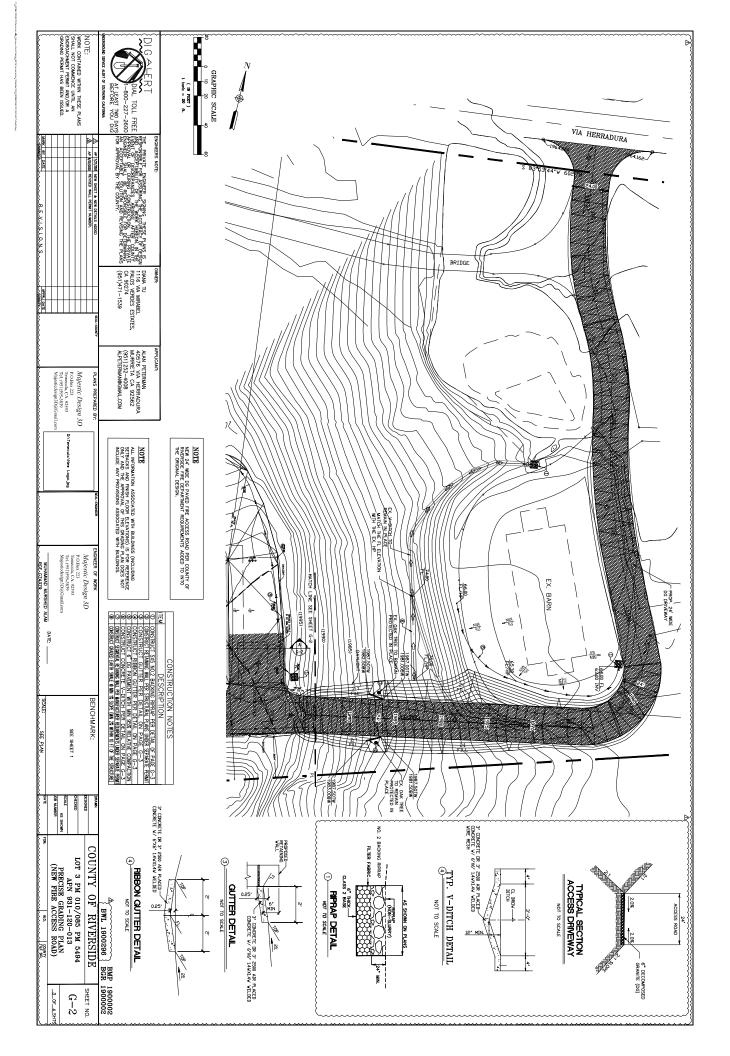
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